

BOARD OF RECREATION AND PARK COMMISSIONERS

BOARD REPORT	NO	20-077
DATEMay 7, 2020	C.D	14
BOARD OF RECREATION AND PARK COMMISSIONERS		
SUBJECT: TRACT MAP NO. VTT-82988 - RECOMMENDATIO AGENCY FOR LAND DEDICATION OR IN-LIEU PARK		
AP Diaz H. Fujita V. Israel N. Williams M. Williams	lu	1
Gen	eral Manag	er
Approved X Disapproved	Withdrav	wn

RECOMMENDATIONS

- 1. Recommend that the Advisory Agency require Tract Map No. VTT-82988 (Project) to pay in-lieu fees to the City in order fulfill the Project's requirements under provisions of Los Angeles Municipal Code Section 12.33; and,
- 2. Authorize the Department of Recreation and Parks' (RAP) General Manager or designee to provide a Report to the Advisory Agency informing them of the Board of Recreation and Park Commissioners' (Board) recommendation.

PARK FEE SUMMARY

Ordinance 184,505 (Parks Dedication and Fee Update Ordinance) became effective on January 11, 2017. Ordinance 184,505 requires most residential projects that create new dwelling units or joint living and work quarters to dedicate land or to pay a fee in-lieu (Park Fee) for the purpose of developing park and recreational facilities. Residential projects that propose one or more additional dwelling units are subject to these requirements unless they meet one of the exceptions listed in Los Angeles Municipal Code (LAMC) Section 12.33 C.3 (e.g. certain affordable housing units and secondary dwelling units may be exempt from any requirement to pay a fee).

LAMC Section 17.03 (Advisory Agency) states that "[t]he Advisory Agency is charged with the duty of making investigations and reports on the design and improvement of proposed subdivisions, of requiring the dedication of land, the payment of fees in lieu thereof, or a combination of both, for the acquisition and development of park and recreation sites and facilities...". The Director of the City Planning Department (City Planning) is designated as the Advisory Agency for the City of Los Angeles and is authorized to act in such capacity through one or more deputies appointed by him or her for that purpose.

PG. 2 NO. 20-077

LAMC Section 17.04 (Subdivision Committee) states that RAP is to submit a Report to the Advisory Agency for each application for subdivision map approval and that report "shall contain recommendations, approved by the Board of Recreation and Park Commissioners, specifying the land to be dedicated, the payment of fees in lieu thereof, or a combination of both for the acquisition and development of park or recreational sites and facilities to serve the future inhabitants of such subdivision... ".

PROJECT SUMMARY

The proposed Project, located at 412 – 426 South Crocker Street and 411 – 425 South Towne Avenue in the Downtown Skid Row community of the City, consists of a mixed-use project with 175 residential units, 173 of which are affordable, and approximately 8,691 square feet (SF) of commercial retail space and a subterranean parking garage.

The proposed Project also includes approximately 9,129 SF of common open space, including two outdoor courtyards and a community room.

The Project, as submitted to City Planning, is not proposing to make a park land dedication to the City of Los Angeles either on-site or off-site of the Project location.

Conceptual renderings of the Project are attached (Attachment 1).

EARLY CONSULTATION MEETING

Pursuant to LAMC Section 12.33 D.1, applicants of residential Subdivision projects with more than fifty (50) residential dwelling units are required to meet with RAP and City Planning prior to submitting a tract map application to City Planning. Per LAMC Section 12.33 D.1, "[t]he purpose of this early consultation is to discuss whether the City requires land dedication for the project and/or to discuss credits available to the applicant, if any."

RAP and City Planning staff held an Early Consultation meeting with Project representatives on <u>March 31, 2020.</u> The meeting included a discussion of the requirements of LAMC Section 12.33, the maximum land dedication that the Project could be required to provide, options and opportunities for on-site or off-site park land dedications, the calculation of Park Fees, and the various recreational credits available to the proposed Project.

ADVISORY AGENCY

The proposed Project filed a tract map application with City Planning on <u>January 7, 2020</u>. On January 15, 2020, the Advisory Agency sent RAP a notification requesting RAP provide its report and recommendations on the Project by a deadline identified as "<u>Upon Receipt</u>." The Advisory Agency Filing Notification is attached (Attachment 2).

It should be noted that City Planning accepted the tract map application for the Project prior to the required Early Consultation meeting. After RAP staff received the above notification, staff contacted City Planning staff and advised them that the project had not yet participated in the

PG. 3 NO. 20-077

required Early Consultation meeting and that the Project application should be placed on hold until the required Early Consultation Meeting was completed. RAP staff advised City Planning staff that RAP's comments for the proposed Project would be provided after the required Early Consultation meeting was held and the Board had an opportunity to consider the project and provide a report to the Advisory Agency.

If no written Report is provided to the Advisory Agency, the Advisory Agency will assume that RAP has no report to make.

REQUIRED LAND DEDICATION AND IN-LIEU FEE PAYMENT

Pursuant to LAMC Section 12.33 C, "All new residential dwelling units and joint living and work quarters shall be required to dedicate land, pay a fee, or provide a combination of land dedication and fee payment for the purpose of acquiring, expanding and improving park and recreational facilities for new residents."

LAMC 12.33 D.2.b states "Any land dedication for park and recreation purposes shall not be deducted from a site's gross lot area for the purposes of calculating project density, lot area, buildable area or floor area ratio."

Land Dedication

LAMC Section 12.33 D states that residential Subdivision projects with more than fifty (50) residential dwelling units can be required by the City to dedicate land to the City for park and recreation purposes. The maximum amount of land that the Advisory Agency could require a project to dedicate to the City is calculated based on the formula detailed in LAMC Section 12.33 D.2:

- LD = (DU x P) x F
 - LD = Land to be dedicated in acres.
 - o **DU** = Total number of new market-rate dwelling units.
 - P = Average number of people per occupied dwelling unit as determined by the most recent version of the U.S. Census for the City of Los Angeles.
 - P = 2.88
 - F = Park Service factor, as indicated by the Department of Recreation and Parks rate and fee schedule.
 - F = 0.00251 (2.51 acres of park land per 1,000 residents)

The **maximum** required land dedication for the Project's proposed 175 units would be:

1.27 Acres =
$$(175 \times 2.88) \times 0.00251$$

The amount of land that is required to be dedicated is subject to change depending on the Park Service factor in effect at the time the Project is required to dedicate the land; the number of exempt dwelling units (e.g. affordable housing units, existing dwelling units to be replaced on

PG. 4 NO. 20-077

site, etc.) included as part of the Project; any Dwelling Unit Construction Tax previously paid by the Project; and, any credits granted by RAP to the Project for improvements to dedicated park land or for eligible privately owned recreational facilities and amenities.

As currently proposed, the Project has 173 affordable units that would likely qualify for an exemption per LAMC Section 12.33 C.3. If those dwelling units are ultimately determined to be exempt, the maximum required land dedication for the Project would be:

0.01 Acres =
$$(2 \times 2.88) \times 0.00251$$

Per LAMC Section 12.33 D.3, land dedications may be made on-site or off-site of the project location. Any off-site land dedication shall be located within a certain radius of the project site, as specified below:

- a) Neighborhood Park: within a 2-mile radius
- b) Community Park: within a 5-mile radius
- c) Regional Park: within a 10-mile radius

While the Advisory Agency has the authority to require the Project to dedicate land to the City for park purposes, the Board would need to approve any proposed park land dedication before that land can be acquired and accepted by the City. Therefore, if the Advisory Agency requires the Project to dedicate land to the City, RAP staff would need to prepare a subsequent report to the Board regarding the proposed land dedication. That report would detail the amount and location of the land being dedicated, and the improvements, if any, proposed to be developed on the dedicated property. Additionally, if it is determined that the Project will provide a combination of land dedication and fee payment, the report would also identify the amount of inlieu fees that would be owed to the City after RAP credits the Project for the amount of land being dedicated.

In-Lieu Fee Payment

Pursuant to LAMC Section 12.33, the Park Fee amount is determined by the type of residential development project (Subdivision or Non-Subdivision) being developed. RAP shall collect these fees pursuant to LAMC Section 19.17 and the Park Fees Section of RAP's Rate and Fee Schedule. As of July 1, 2019, Residential Subdivision projects that are subject to the Subdivision fee shall pay:

\$12,998.00 x number of new non-exempt dwelling units

The **maximum** Park Fees payment for the Project's proposed 175 units would be:

 $$2,274,650.00 = $12,998.00 \times 175$ dwelling units

PG. 5 NO._20-077

As currently proposed, the Project has 173 dwelling units that would likely qualify for an exemption per LAMC Section 12.33 C.3. If those dwelling units are ultimately determined to be exempt, the **maximum** required Park Fee payment for the Project would be:

\$25,996.00 = \$12,998.00 x 2 dwelling units

The amount of Park Fees that are required to be paid is subject to change depending on the Park Fee schedule in effect in the year of payment; the number of exempt dwelling units (e.g. affordable housing units, existing dwelling units to be replaced on site, etc.) included as part of the Project; any Dwelling Unit Construction Tax previously paid by the Project; and, any credits granted by RAP to the Project for improvements to dedicated park land or for eligible privately owned recreational facilities and amenities.

Per LAMC Section 12.33 E.3, any Park Fees collected by the City shall be expended within a certain radius from the project site, as specified below:

- a) Neighborhood Park: within a 2-mile radius
- b) Community Park: within a 5-mile radius
- c) Regional Park: within a 10-mile radius

STAFF ANALYSIS AND RECOMMENDATION

In order for RAP staff to determine which mechanism, land dedication or payment of Park Fees, to recommend for the Board's review and approval, RAP staff analyzes each proposed development project, including its location, new population, surrounding parks, any nearby active or proposed park acquisition or park development project, existing park service radius gaps, etc. RAP staff also analyzes any parks, open spaces, or recreational areas anticipated to be provided by each proposed development project in order to determine if those facilities reduce the need for new public recreation and park facilities to serve the project residents.

One of the most critical factors that RAP staff uses to analyze proposed developments is existing park service radius gaps. Approximately 54% of residents in the City of Los Angeles live within a one-half mile, or a 10 minute walk, from a public park or open space. The Mayor's Office of Sustainability pLAn sets a goal of increasing the percentage of Angelenos living within a one-half mile from a park to 65% by 2025 and to 75% by 2035. RAP has employed a variety of strategies, such as the 50 Parks Initiative, that are intended to increase park access and meet these park access goals.

Site Analysis

The proposed Project is located within the Downtown Skid Row community of the City and within the Central City Community Plan Area. Currently, the Project site is a vacant food processing plant. The proposed Project is surrounded by industrial uses on all sides.

PG. 6 NO. 20-077

An aerial view of the Project site is attached hereto (Attachment 3). A map showing the generalized zoning of the project site is also attached (Attachment 4).

The proposed Project is located in a high-density area of the City. Below is analysis of the density of the area within walking distance of the Project site and a comparison to both citywide density and local community density:

- Half-mile (½) walking distance of the Project site (EPADSS): 12,829 persons (22,119 persons per square mile)
- City of Los Angeles Population Density (2010 United States Census): 8,092 persons per square mile.
- Central City Community Plan Area (2017 American Community Survey): 11,424 persons per square mile

Project Open Space and Recreational Areas

As previously discussed, the proposed Project also includes approximately 9,129 SF of common open space, including two outdoor courtyards and a community room.

The amount of common open space being provided by the proposed Project does not appear to significantly exceed the amount of open space the proposed Project would otherwise be required to provide per LAMC Section 12.21 (or other planning documents, specific plans, etc.). Additionally, it does not appear that these open spaces will include the type and variety of active and passive recreational facilities and amenities that are typically found in the City's Neighborhood and Community Parks and that are needed to meet the needs of residents of all ages and abilities.

As currently proposed, these recreational amenities would likely not significantly reduce the Project's impact on existing public recreational and park facilities nor would they likely significantly reduce the need for new or expanded public recreational and park facilities to serve the Project's residents.

Public Park Access

There are three RAP-operated public parks within a half-mile walking distance from the Project site. A map showing the project location and nearby public parks is attached hereto (Attachment 5).

- The Arts District Park, located at 501 South Hewitt Street, is a 0.5-acre park that features a small plaza, amphitheater, play area, benches, picnic areas and landscaping.
- San Julian Park, located at 315 East 5th Street, is a 0.29-acre facility that provides an open lawn area, picnic tables and benches, and two shade structures.
- 6th & Gladys Street Park, located at 808 E. 6th Street, is a 0.34-acre facility that includes picnic tables, half-court basketball, and outdoor exercise equipment.

PG. 7 NO._20-077

As previously noted in this Report, a land dedication for a new public park could be located either on-site or off-site of the Project location. If a new public park was provided at the Project location the park would serve the new residents of the Project and would serve approximately $\underline{\mathbf{0}}$ new, previously unserved, residents within a half-mile walking distance (Attachment 6). If a new public park was provided off-site of the Project location the park would serve the new residents of the Project as well as an unknown number of new, previously unserved, residents within a half-mile walking distance. If the proposed Project does elect to make some or all of its required land dedication off-site, staff would work with the Project to identify a site that would serve project residents, help close an existing park service area gap, and maximize, to the extent feasible, the number of new residents who would be within a half-mile walking distance of a public park.

Nearby Public Park Projects

There are two new public parks currently in development within a two-mile radius of the Project site.

- 1st and Broadway Park is a 1.96-acre park located at 217 West 1st Street in Council District 14. The current scope of the 1st and Broadway Park Development (PRJ20781) Project is the development of a new community park. The 1st and Broadway Park Development (PRJ20781) (PRJ21252) Project is currently in the bid and award stage. The 1st and Broadway Park Development (PRJ20781) (PRJ21252) Project is being led by the Bureau of Engineering (BOE). It is unknown when the 1st and Broadway Park Development (PRJ20781) (PRJ21252) Project will be completed. The current project budget for the 1st and Broadway Park Development (PRJ20781) (PRJ21252) Project is Twenty-Eight Million Dollars (\$28,000,000.00) and the current available funding is Nineteen Million, Eight Hundred Forty Thousand, Four Hundred Fourteen Dollars and Thirty-One Cents (\$19,840,414.31). The 1st and Broadway Park Development (PRJ20781) (PRJ21252) is not fully funded at this time.
- Alpine Recreation Center Expansion (Ord and Yale Street Park (PRJ20591) is a 0.85-acre park located at 817 Yale Street in Council District 1. The current scope of the Ord and Yale Street Park Project is the construction of a children's playground with equipment and climbing wall, the construction of a fitness zone with eight pieces of equipment, construction and entry plaza/performance space with small cafe and restroom building, construction of an upper viewing terrace with public art water feature, and the construction of a fitness trail on the Native Restoration Garden slope and through the Bamboo Grove. The Ord and Yale Street Park Project is currently under construction. The development of the Ord and Yale Street Park Project is being led by Department of Public Works, Bureau of Engineering (BOE) and is expected to be completed in August 2020. The Ord and Yale Street Park Project is fully funded at this time.

PG. 8 NO. 20-077

There is one major park renovation projects currently in development within a two-mile radius of the Project site:

• Boyle Heights Sports Center, located at 933 South Mott Street, is an 8.51-acre facility featuring a variety of recreational amenities, including two baseball diamonds, outdoor basketball courts, a track field, multipurpose sports field, synthetic field, and community room. The Boyle Heights Sports Center Project proposes the development of a new 17,500-square-foot recreation center at the existing Boyle Heights Sports Center. The facility would consist of a full-sized basketball court, staff offices, equipment storage rooms, restrooms, showers, a community room, elevator, multi-purpose rooms (programming may consist of a dance studio, performing area, exercise/yoga, dance, and ballet), plaza for special gatherings, additional green space, pedestrian paths, and additional parking. The Boyle Heights Sports Center Project is being led by the Bureau of Engineering (BOE). This project has not started construction. The current project budget for the Boyle Heights Sports Center Project is \$28.2 Million Dollars. The Boyle Heights Sports Center Project is not fully funded at this time.

Staff Recommendation

The proposed Project is located in a high-density area of the City. The density of the surrounding area within walking distance of the Project site is higher than the average density of the City and is higher than the average density of the Community Plan Area in which the proposed Project is located.

The Project site is not located in an existing park service radius gap. There are three RAP-operated public parks within a half-mile walking distance from the Project.

There are two public parks currently in development within a two-mile radius of the Project site.

There is one park renovation project currently in development within a two (2) mile radius of the Project site.

If a new public park was provided at the Project location, the park would serve Project residents and 0 currently unserved residents within a half-mile walking distance.

As noted earlier in the Report, 173 of the 175 proposed residential units will likely qualify for the affordable housing exemption. Thus, a potential land dedication would be just 0.01 acres.

Therefore, RAP staff recommends that the appropriate mitigation measure for this proposed Project is the payment of in-lieu fees to the City.

FISCAL IMPACT

As it is not known at this time if the Advisory Agency will recommend the proposed Project dedicate park land to the City or to pay Park Fees, the potential Fiscal Impact to RAP's General Fund is unknown.

PG. 9 NO. 20-077

STRATEGIC PLAN INITIATIVES AND GOALS

Approval of this Board Report advances RAP's Strategic Plan by supporting:

Goal No. 3: Create & Maintain World Class Parks and Facilities

Outcome No. 3: Increased park maintenance, with a focus on cleanliness.

Result: Collected fees will fund capital improvements at existing parks in the Project area

This Report was prepared by Ligaya Khennavong, Management Assistant, Planning, Maintenance and Construction Branch.

LIST OF ATTACHMENTS

- 1) Conceptual Project Renderings
- 2) Advisory Agency Filing Notice
- 3) Aerial View of Project Site
- 4) Generalized Zoning
- 5) Project Location and Surrounding Parks
- 6) EPADSS Report

414 Crocker Apartments

An Affordable Housing Development 414 Crocker Street, Los Angeles, CA 90013

CLIENT

LITTLE TOKYO SERVICE CENTER

231 E Third Street, G-106, Los Angeles, CA 90013



PROJECT SUMMARY:

LEGAL DESCRIPTION

412-426 Crocker Street and 411-425 Towns Avenue Site Address ZIP Code Lot/Parcel Area (Per ZIMAS) Thomas Brothers Grid 90013 35.767 sf PAGE 634 - GRID G5 asor Percei No. (APN) 5147-009-027 Wolfield Orchard Track M R 30-9/13 Lot Arb (Lot Cut Reference) Map Sheet VTTM: 127-5A213

PROJECT DESCRIPTION:

Expanded Project Description:
The Development of a 100 % affordable Mitted Use complex with 178 units of attrotiable househopment of a 100 % affordable Mitted Use complex with 178 units of attrotiable househopment of a 100 % affordable Mitted Use of a universal one remaining and 6.08 if of commercial and vesting providing a minimum of 19-peading statility, and 122-bloycle statility. General Plan Amendment from Light Maturisationing to Registrate Connected and vesting Zone Change and Height Destrict Change Brain Mc2016 C2-40. This Project will utilitize one (1) JJJ Incentive to individ 150% does Repeated Connected and Vesting Tendrive Tract May No. 6008%, This Project is within the Greater Dovertions Housing Incentive Amen which allows from the following and organized Amen which allows for the following a layed recognition and one of the second or the following and your development of the unit of the 100 Mitted State (1) and 100 Mitt

General Pfer: Amendment changing the Land Use Designation from Light Manufacturing to Regional Center Commercial, LAMC Section 11.5.6

Vesting Zone Change and Height District Change from M2-20 to C2-40. LANC Section 12.32Q. The zone change request would include Developer incentives for

Sits Plan Review for a development with more than 50 dwelling units and/or a non-residential building in excess of 50,000 as ft. LAMC Section 16.05

Vesting Tentative Tract Map for the aubdivision of airspace into three lots pursuant to LAMC Section 17.01.

= 176 UNITS = 86 / 60 / 29 = 84'-8" / 7 STORIES

PROPOSED BUILDING AREA (TOWARD F.A.R.)

REQUIRED (Residential):	
1 Long-Term Stall / 1 Units (1-25)	= 25 STALLS
1 Long-Term Stall / 1.5 Units (26-100)	
1 Long-Term Stall / 2 Units(101-175)	= 3B STALLS
1 Short-Term Stall / 1 per 10 (1-25)	≈ 3 STALLB
1 Short-Term Stall / 1 per 15 (28-100)	= 5 STALLS
1 Short-Term Stall / 1 per 20 (101-175)	= 4 STALLS
TOTAL REQUIRED	= 125 STALLS
PROVIDED (Rasidential):	
LONG-TERM STALLS	= 113 8TALL8
SHORT-TERM STALLS	= 12 STALLS
TOTAL PROVIDED	= 125 STALLS

ZONING ANALYSIS/DENSITY CALCULATIONS:

A. SITE ANALYSIS	
ZONING:	= C2-4D
LOT AREA (Per ZIMAS):	= 35,767 SF
B. ZONING ANALYSIS (C2-4D ZONE)	
BUILDING HEIGHT (Allowed / Proposed)	= Unlim!ted / 85*
SETBACK REQUIREMENTS	
- REQUIRED (Front / Side / Rear Yard)	= 0' / 0' / 0' *
- PROVIDED (Front / Side / Rear Yard)	= C / S / 15
* Per LAMC Section 12.03 "Greater Downtown Hosping Incentive	Aren"

C. DENSITY CALCULATIONS (C2-4D ZONE) BASE DENSITY (M2-20) (35,750 / 400) ALLOWABLE DENSITY PROPOSED DENSITY # 89 LINITS = UNLIMITED * = 175 UNITS Per LAMC Bection 12.03 "Greeter

D. F.A.R. CALCULATIONS (C2-4D ZONE)
BASE F.A.R.:
() L'Intérion Established by ORD 164,307)
ALLOWABLE F.A.R. (With Zone Changa):
PROPOSED F.A.R.:
TOTAL AREA ALLOWED (35,767 SF x 6)
TOTAL PROPOSED AREA

VESTING ZONE CHANGE FROM NO-ZO TO CZ-4D LAMC SECTION 12.52 Q.

PARKING SUMMARY (VEHICULAR):

REQUI

RED (Residential): RED (Commercial): (8.691 SF / 1.000 SF = 9)	= 0 STALLS *	ACCESSIBLE U	NIT COUNT
RED (Meneger Units):	= 2 STALLS ***		MOBILITY UNITS
DED: STANDARD	= 11 STALLS	Unit Tyou Count	Count % Unit Type
COMPACT	= 8 STALLS		9 10% 6 10%
TOTAL PROVIDED	= 18 STALLS	28 29	3 10%
Per LAMC Section 12:03 'Greater Downtown Housing Incentive	Area" Borsas to allow	TOTALS 178	18 10%

The LIMIT Section 12.00 "Greater Downtown Statistics listensity Anna" Sorsat to allow one partial negation for at time lass than SSEA, Mail Section 12.00 S.F. for Buildings 73.00 S.O. Or More Section 12.00 S.F. for Section 73.00 S.O. Or More Per LIMIT Section 12.00 Se

PARKING SUMMARY (BICYCLE):

A RESIDENTIAL (5-Story Type III-A Construction) RESIDENTIAL (18,326 X 5):	=1	13,758 SE
RESIDENTIAL (18.326 X 5):	=	91,630 SF
CIRCULATION & SERVICE (4,824 +4,326 X 4):	=	22,128 8F
B. PODRIM (2-Story Type I-A Construction)	-	48,655 8F
RESIDENTIAL:	=	16,373 SF
COMMUNITY (4,333 + 1,799);	21	6,132 SF
COMMERCIAL:	=	8,691 SF
CIRCULATION & SERVICE (2,232 + 5,925):		8,158 SF
UN-ENCLOSED SPACE ON GROUND FLOOR:	=	7,301 8F
C. BASEMENT		18.820 SF
PARKING:	=	10.947 SF
CIDCUITATION & SEDVICE:	-	7 973 9E

OPEN SPACE CALCULATIONS

TOTAL OPEN SPACE (With 50% Reduction)

= 3.625 SF = 18,225 8F

* 9.113 SF

tings on 2nd Flor

Count % Unit Type

JIRED (Residential):
88 Studies @ 100 SF / UNIT
60 1-Badroom @ 100 SF / UNIT
29 2-Badroom @ 125 SF / UNIT
TOTAL OPEN SPACE (Base)

COMMUNITY SPACE COVERED COURTYRAD

UNIT SUMMARY

HOUSING (TYPE I-A)

HOUSING (TYPE III-A)

BUILDING AREA:


UNCOVERED COURTYRAD

Utilizing ALI Developer Incentive to Alicer 50% Reduction
 Community Space Includes All Community Room and Re

VICINITY MAP:

DRAWING NOT TO SCALE

DRAWING INDEX:

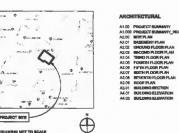

UNDER SEPARATE PERMIT OR APPROVAL

THIS BUILDING SHALL BE PROVIDED WITH A MANUAL ALARM SYSTEM WITH THE CAPABILITY TO SUPPORT VISIBLE ALARM NOTIFICATION APPLIANCES IN ACCORDANCE WITH NFPA 72, DESIGN BUILD BY

PROVIDE EMERGENCY RESPONDER RADIO COVERAGE IN ACCORDANCE WITH LAFC 510 (CBC 916.1)

FUTURE SOLAR PHOTOVOLTAIC SYSTEMS

FIRE SPRINKLER SYSTEMS PER NFPA 13 DESIGN. - BUILD BY CONTRACTOR

REQUIRED SUSTAINABLE BUILDING METHODS:

- OUTDOOR WATER CONSERVATION MEASURES INCLUDE:

 USE NATIVE OR DROUGHT-TOLERANT PLANTS FOR A MINALUM OF TRY, OF LANDSCAPED, AND TO TO BE ELECTED PROM LOS STANDS FOR THE STAND
- ALL PROJECTS, AT MINIMUM, SHALL RECYCLE AND/OR SALVAGE 70% OF MON-HAZARDOUS CONSTRUCTIN AND DEMOLITION
- DEBRUS.
 THE PROJECT SHALL PROVIDE AN EASILY-ACCESSIBLE RECYCLING AREA FOR TENANT USE THAT SERVES THE ENTIRE

ARCHITECTS MALGESYARCHTECTS.COM

2902 KNOX AVE. ZHD FLOOR LOS ANGELES, CA 90038 WWW.FSYARCHITECTS.COM

PROJECT RAISE
414 CROCKER STREET
AFFORDABLE HOUSING PROJECT ADDRESS: 414 S Ctocker Street, Las Angeles, CA 80013

CLERT HAME: LITTLE TOKYO SERVICE CENTER

GLESTY ADDRESS: 8431 Weekey Street, Butto F Dahver City, CA 90232

DRAWING TITLE PROJECT SUMMARY

DESCRIPTION


Project Number

DATE

HOT FOR CONSTRUCTION Project Status

lesue Date Author Checker

A1.00

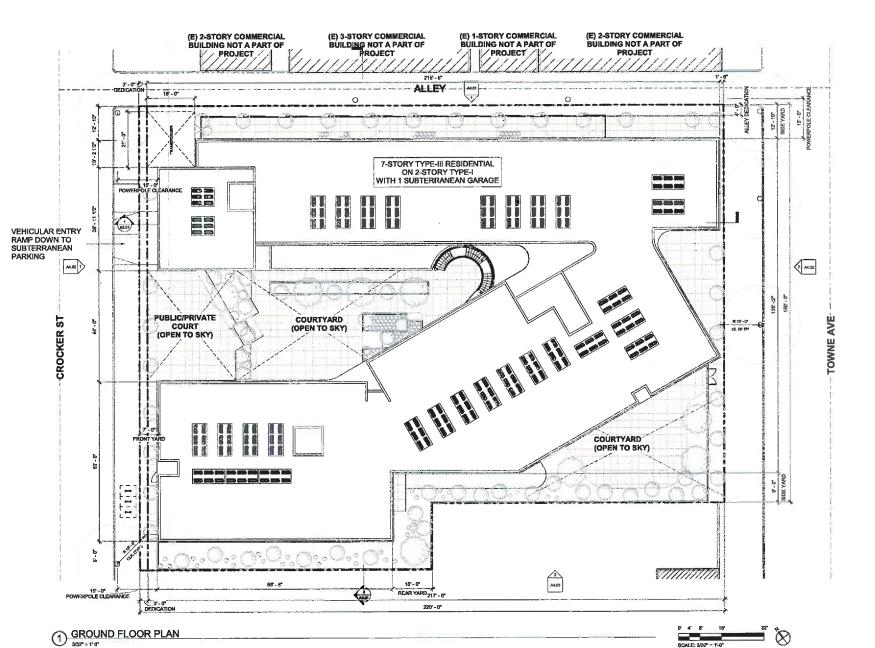

2902 KNOX AVS., 2ND HLDOR LOS ANCELES, CA 90039 TEL : 323.265.4343 WWW.FSYARCHITECTS.COM ARCRITECTS MALESTEVARCHITECTS.COM

DATE

PROJECT NAME: 414 CROCKER STREET AFFORDABLE HOUSING PROJECT ADDRESS: 414 S Crocker Street, Los Angeles, CA 9001:

CLIENT NAME: LITTLE TOKYO SERVICE CENTER CLENT ADDRESS: 3431 Weekly Street, Builto I Culver City, UA 90232

SITE PLAN


PROJECT NUMBER Project Number

NOT FOR CONSTRUCTION

Issue Date Author Checker

A2.00

3/32" = 1'-0"

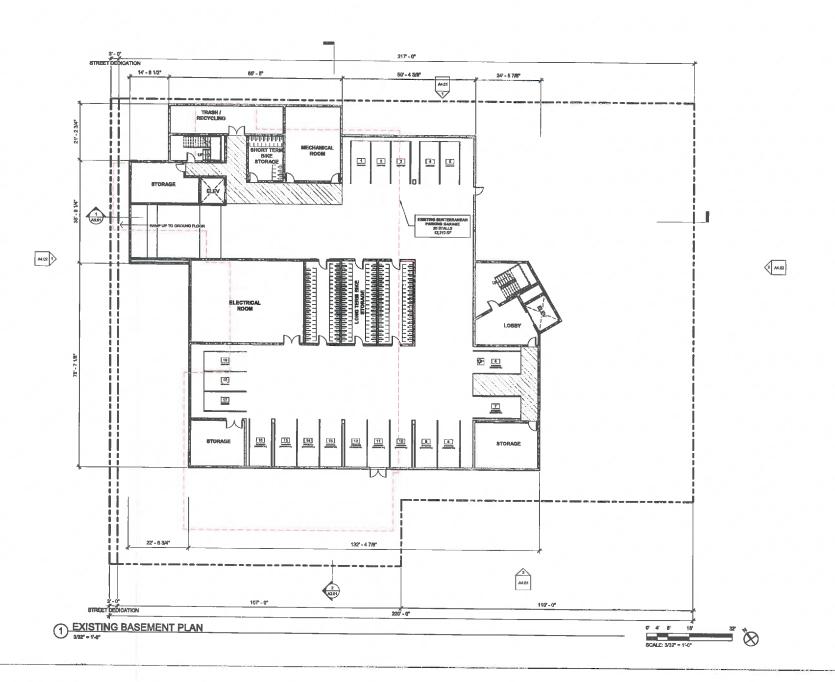

- 3. BITRUCTURAL COLUMN (SEE STRUCTURAL
- 5. DOUBLE STRIPING OF PARKING STALLS PER CITY OF LABUILDING DEPARTMENT STANDARDS

LONG-TERM WALL-NOUNTED BICYCLE STORAGE STILLS W/ DIMENSIONS COMPLYING WITH BICYCLE PARGING OFDINANCE OF 12-1287-81. STALLS ARE ENCLOSED WITHIN WEST-BERPROOF CLOSET W/ DOORS PER PLAN, TYP.

- 8. ELECTRICAL EQUIPMENT
- B. EDGE OF BUILDINGWAY KWAY ARCHIT
- 10. WROUGHT FROM METAL FERCE (6-0" TALL)
- 12. FDGE OF OVERHEAD ENTRANCE CANOPI 13. BLIDING SECURITY GATE ON TRACK
- 14. CONCRETE BOLLARDS (PER LADWP REQUIREMENTS)
- 15. SHORT-TERM BIKE PARKING STALL, TYP.
- 17. STUCCO FINISH (SEE ELEVATIONS FOR ADD'L FINISH INFORMATION)

2902 KNOX AVE, 2ND FLDDR LOS ANGELES, CA 10039 TEL: 323,255,4343 ARCHITECTS MALESTEVANCHITECTS.COM

PROJECT NAME: 414 CROCKER STREET AFFORDABLE HOUSING PROJECT ADDRESS: 414 S Crocker Street, Los Angeles, CA 80013

CLIENT RAINE: LITTLE TOKYO SERVICE CENTER


DRAWNO TITLE: BASEMENT PLAN

PROJECT NUMBER Project Number NO, BESCRIPTION DATE

Project Status Issue Date Author Checker

A2.01

3/32" = 1'-0" Oti1827-414 Occior Street(I) - Production(2) Schemetic Design(Reet)(14 Crocker St. Entitlement Set av.

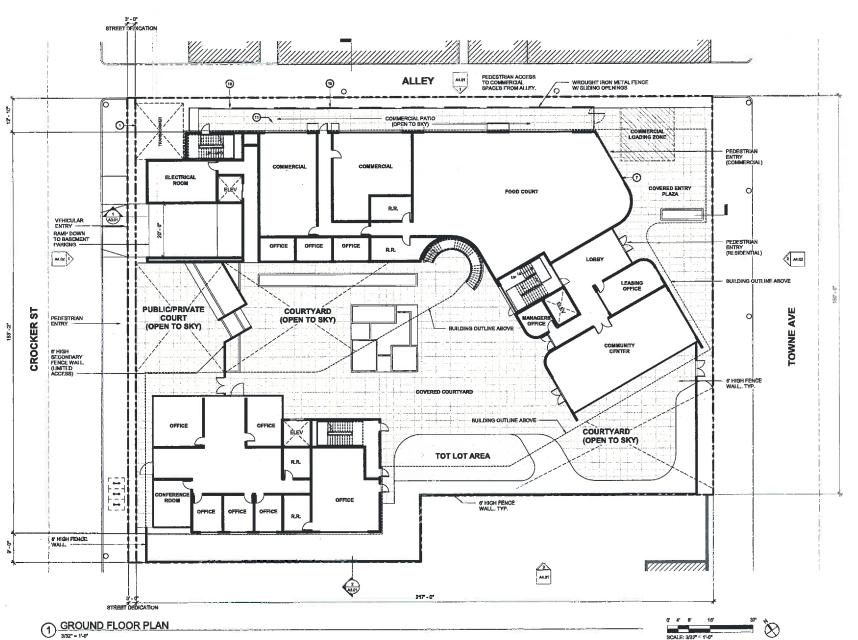

- 2. CONCRETE BLAB ON GRADE
- 3. STRUCTURAL COLUMN (NEE STRUCTURAL DRAWINGEN)
- SOFTSCAPE LANDSCAPING / PLANTING (SEE LANDSCAPE DRAWINGS)

- LONG-TERM WALL-MOUNTED BICYCLE BYORAGE BY ALLS W/ DIMENSIONS COMPLYING WITH BICYCL PARGING ORDINANCE OF 12-1297-51. STALLS ARE ENCLOSES WITHIN WEATH-TOPROOF CLOSET W DOORS! PER PLAN, TYP.
- 7 STOKEFRONT ASSEMBLY (ARCADIA OFFSET DYNIBLE GLAZINO).
- 6. ELECTRICAL FOURMENT
- 9. FDGE OF BUILDINGWALKWAY ABOVE
- 10. WROUGHT IRON METAL FENCE (6-0" TAIL) WALDING OPENINGS
- 11. DN-GRADE PLANTERS (SEE LANDSCAPE DRAWBUSE)
- 13 SLIDING SECURITY GATE ON TRACK
- 14. CONCHETE BOLLARDS (PER LAUWP REQUIREMENTS)
- 18. SHORT TERM BIRE PARKING STALL, TYP.
- III. PROVIDE USPS APPROVED 4C MALIBOXES (FOR 75 UNITS INCLUDING REQUIRED PARCEL STORAGE). CONTRACTOR TO VEREY LOCATION AND TYPS: WITH POSTMASTIAN PRIOR TO PURCHASE AND INSTALLATION.
- 17. STUCCO FINISH (SEE ELEVATIONS FOR ADDIT FINISH INFORMATION)

2802 KNOX AVE, ZND FLOOR TEL: 323,255,4343 ARCHITECTS MALESTARCHITECTS.COM

PROJECT NAME: 414 CROCKER STREET AFFORDABLE HOUSING

CLENT NAME: LITTLE TOKYO SERVICE CENTER

GROUND FLOOR PLAN


PROJECT NUMBER Project Number DESCRIPTION DATE

NOT FOR CONSTRUCTION

Author Checker

A2.02

3/32" = 1'-0"

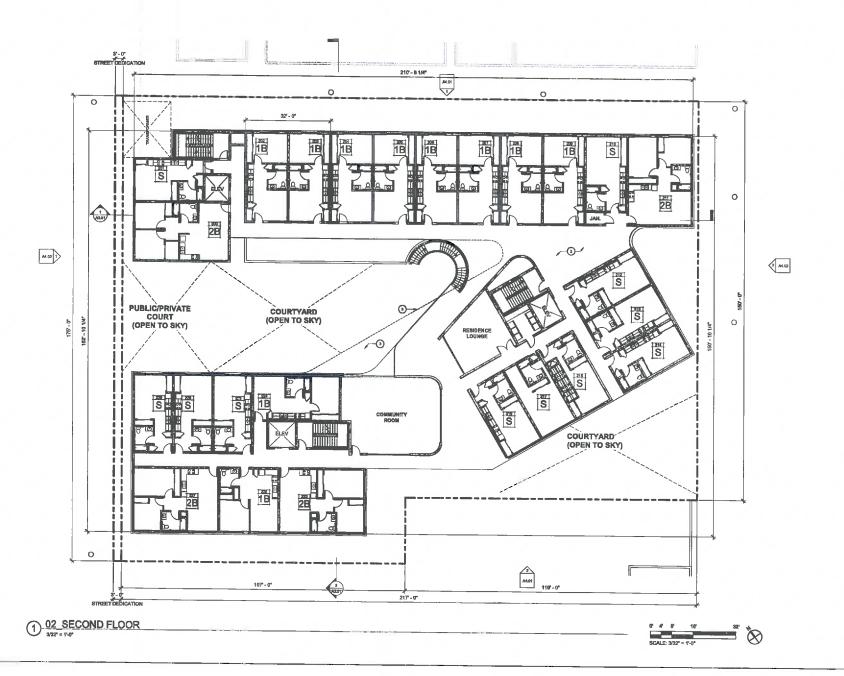

- 2. CONDRETE N. AR DALGRADE
- 3. STRUCTURAL COLUMN (SEE STRUCTURAL DRAWINGS)

- 7. STOREFRONT ASSEMBLY (ARCADIA OFFISET DOUBLE GLAZING).
- 6. BLECTRICAL EQUIPMENT
- 10. WROUGHT IRON METAL FENCE (#-0" TALLS
- 13. SLEINIG SECURITY GATE ON TRACK
- 14. CONCRETE BOLLAROS (PER LADWP REQUIREMENTS)
- 18. SHORT-TERM BIKE PARKING STALL, TYP. 18. PROVIDE USPS APPROVED 4C MALBOXES FOR TO UNITS INCLUDING REQUIRED PARCEL STORAGE, CONTRACTOR TO VEREY LOCATION AND TYPE WITH POSTMASTER PROFIT D PURCHASE AND INSTALLATION.
- 17. STUCCO FINISH (SEE ELEVATIONS FOR ADDL FINISH SEPORMATION)

LOB ANGELES, CA 90039 TEL: 323,258,4343 WWW.F8YARCHITECTS.COM ARCHITECTS MALGESYARCHITECTS.COM

2902 KNOX AVB. 2HD PLDOR

PROJECT NAME: 414 CROCKER STREET AFFORDABLE HOUSING PROJECT ADDRESS: 414 6 Crooler Street, Los Angeles, CA 90013

CUENT NAME: LITTLE TOKYO SERVICE CENTER

CLIENT ADDRESS: 343? Wesley Street, Bulle F Culver City, CA 90232

DRAWING TITLE: SECOND FLOOR PLAN


PROJECT NUMBER Project Number DEBCRIPTION DATE

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Project Status Isaue Dete Author Checker

A2.03

Scale 3/32" = 1'-0" ON1927 - 418 Cracker Street(1) - Production(12_Bc)
Dasign/RevISA1A Cracker St - Entitlement Setunt

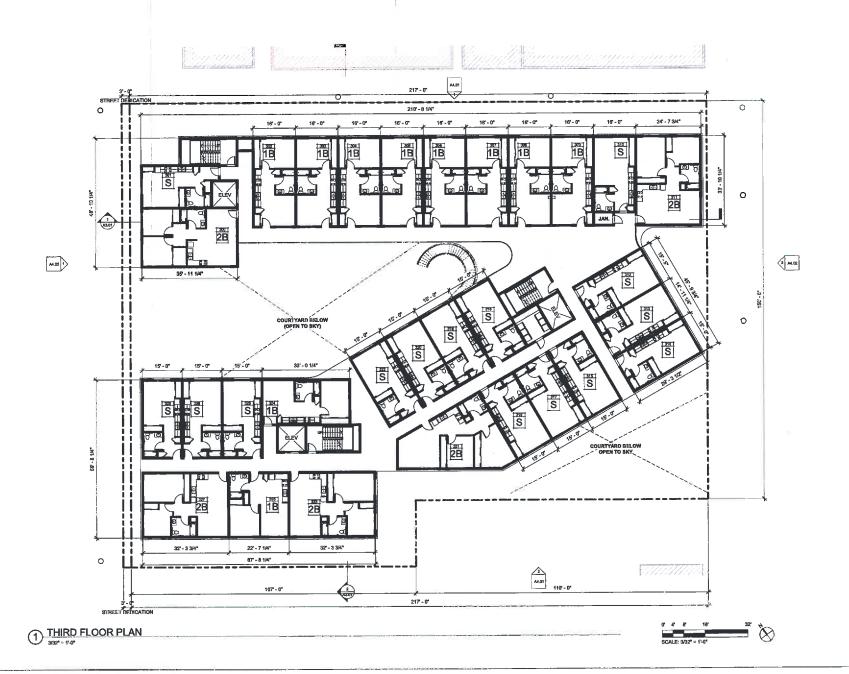

- 2. CUNCHETE SLAB DN-GRADE
- 3. STRUCTURAL COLUMN (SEE STRUCTURAL DRAWINGS)
- SOFTSCAPE LANDSCAPING / PLANTING (SEE LANDSCAPE DRAWINGS)

- 7. STOREFRONT ASSEMBLY (ARCADIA OFFSET DOUBLE GLAZING
- 6. ELECTRICAL FOURMENT
- 10. WROUGHT IRON METAL FENCE (#-4"TALL)
- 11. ON GRADE PLANTERS (SEE LANDSCAPE DRAWINGS)
- 13, SLIDING BEGURDLY GATE ON TRACK
- 14. CONCRETE BOLLARDS (PER LADWP REQUIREMENTS)
- 16. SHORT-TERM BIKE PARKING BTALL, TYP
- 17. STUCCO FINISH (SEE FLEVATIONS FOR ADDIL FINISH INFORMATION)

LDS ANGELES, CA 80039 TEL: 323.255.4343 ARCHITECTS MALGEFRARCHITECTS.COM

PROJECT NAME: 414 CROCKER STREET AFFORDABLE HOUSING PROJECT ADDRESS: 414 S Crocker Street, Las Asseige, CA 90013

CLENT NAME: LITTLE TOKYO SERVICE CENTER CLE-RIT ADDRESS: 3431 Weeley Street, Suits F Cutver City, CA 80232

DRAWING ITTLE: THIRD FLOOR PLAN


Project Number PROJECT NUMBER NO. DESCRIPTION DATE

NOT FOR CONSTRUCTION

Issue Date Author

A2.04

3/32" = 1'-0" O/1827 - 414 Crocker Bireef()1 - Production()2 Schemeti DesturiPark()14 Crocker St - Entitlement Batunt

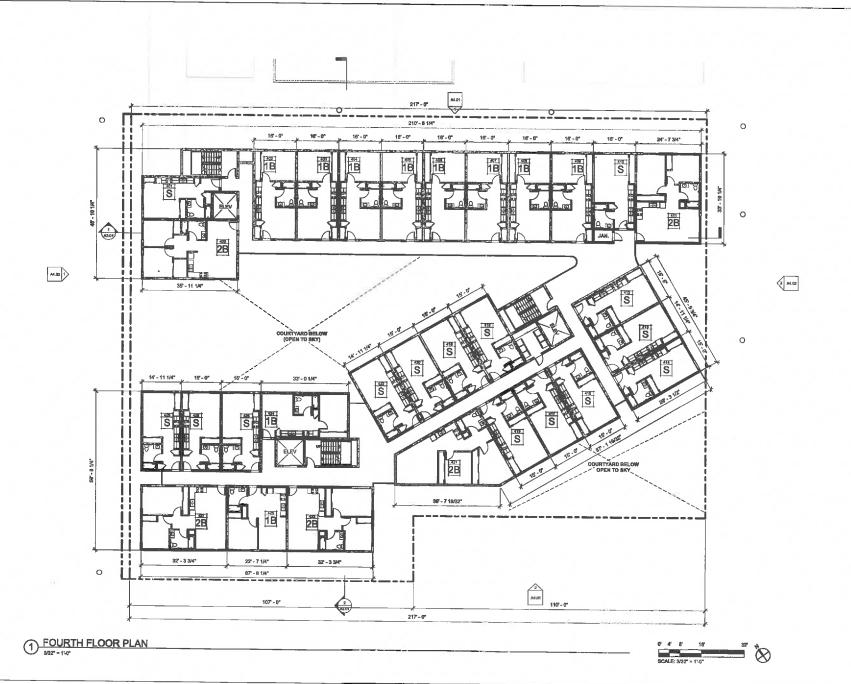

1. STRUCTURAL COLUMN (SEE STRUCTURAL DRAWNSS)

DOUBLE STRIPING OF PARKING STALLS PER CIT OF LA BUILDING DEPARTMENT STANDARDS

LONG-TERM WALL-MOUNTED BICYCLE STORAGE STALLS W/ DIMENSIONS COMPLYING WITH BICYCLE PARKING DRDIVANCE CF 12-1267-81, STALLS ARE ENCLOSED WITHIN WEATHERPROOF CLOSET W/ DOORS PER PLM, TYP.

8. BLECTRICAL EQUIPMENT

9. EDGE OF BUILDINGWALKWAY ABOVE

10. WROUGHT IRON METAL FENCE (8-0" TALL)

12. FIDGE OF OVERHEAD ENTRANCE CANOR

13. IB IDING SECURITY GATE ON TRACK

15. SHORT-TERM BIKE PARKING STALL, TYP.

18. PROVIDE USPS APPROVED 4C MAILROXES (FOR 75 UNITS INCLUDING REQUIRED PARCEL STORAGE). CONTRACTOR AND TYPE WITH POSTMARTER PRIOR TO PURCHASE AND INSTALLATION.

17. STUCCO FINISH (SEE ELEVATIONS FOR ADDY, FINISH INFORMATION)

2902 KNOX AVE, 2ND FLOOR LOS ANGELES, CA SOCIO TEL: 323.258.4343 WWW.FSYARCHITECTS.COM ARCHITECTS MALGERYARCHITECTS.COM

PROLECT NAME:
414 CROCKER STREET
AFFORDABLE HOUSING
PROJECT ADDRESS:
414 8 Cooler Street,
Los Angules, CA 80015

LITTLE TOKYO SERVICE CENTER

GLENT ADDRESS: 3491 Wesley Street, Suite F Culver City, GA 80232

FOURTH FLOOR PLAN


PROJECT NUMBER Project Number NO. DESCRIPTION DATE

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Issue Date Author Checker

A2.05

3/32" = 1'-0" Ont 827 - 414 Citacion Street 01 - Production 02_Schemetic BeelgniRevit(414 Chacker St.- Entitlement Setund

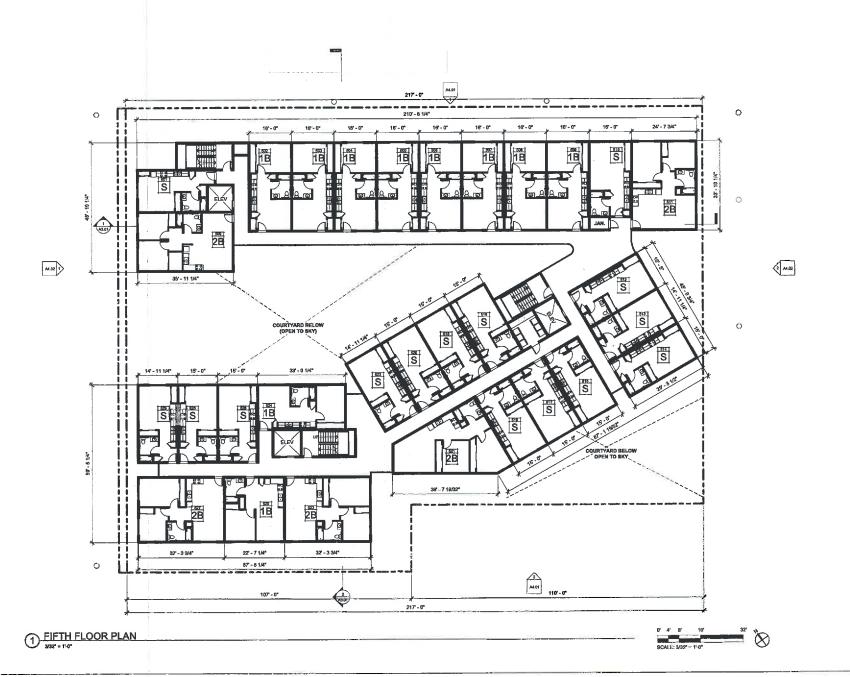

- 2 CONCRETE BLAB UN-GRADE
- 3. STRUCTURAL COLUMN (SEE STRUCTURAL

- 12. EDGE OF OVERHEAD ENTRANCE CANOP
- 13. BLIDNG SECURITY GATE ON TRACK
- 14. CONCRETE BOLLARDS (PER LADWP REQUIREMENTS)
- IB. PROVIDE USPS APPROVED 4C MALBOXES (FOR 75 UNITS INCLUDING REQUIRED PARCIL STORAGE). CONTRACTOR TO VEREY LOCATION AND TYPE WITH POSTMASTER PRIOR TO PURCHASE AND INSTALLATION.

2902 KNOX AVE., 7ND FLOOR LOS ANGELES, CA 90039 TEL: 323,256,4343 ARCHITECES MANOFSYARCHITECTS.COM

PROJECT NAME: 414 CROCKER STREET AFFORDABLE HOUSING PROJECT ADDRESS: 414 S Crocker Street, Los Angeles, CA 90013

CLIENT NAME: LITTLE TOKYO SERVICE CENTER CLE:NT ADDRES:80: 3431 Weekly Street, Suite F Cultur City, CA 90232

DRAWING TITLE:


FIFTH FLOOR PLAN PROJECT NUMBER

Project Number NO. DESCRIPTION DATE

MOT FOR CONSTRUCTION

A2.06

3/32" = 1'-0"

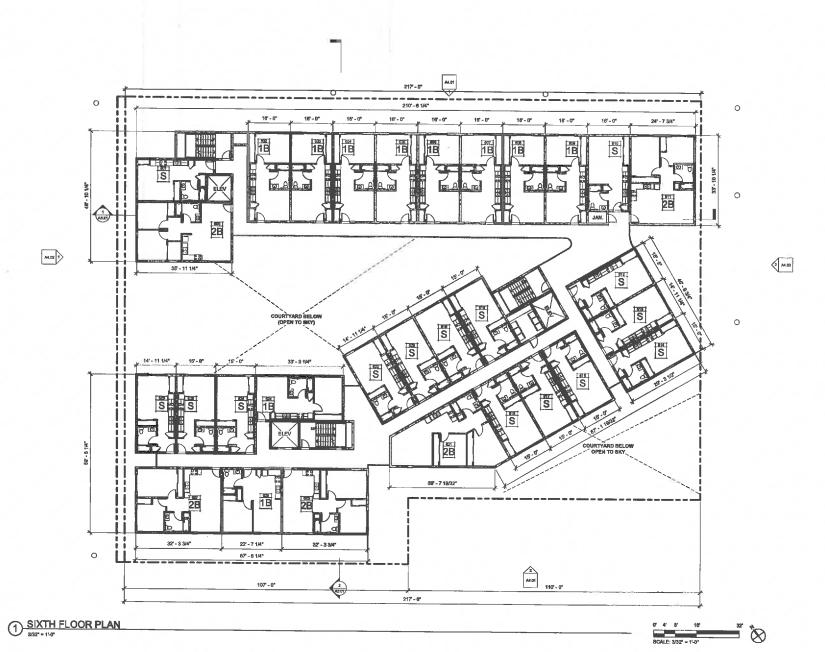

- 3. STRUCTURAL COLUMN (SEE STRUCTURAL DRAWINGS)

- STOREFRONT ASSEMBLY (ARCADIA OFFSET DOUBLE GLAZING).
- IL ELECTRICAL EQUIPMENT
- IL EDGE OF BUILDING/WALKWAY ABOVE
- 10. WROLIGHT FRON METAL FENCE (6'-0" TALL) 11. ON-GRADE PLANTERS (SEE LANDSCAPE DRAWINGS)
- 12. EDGE OF OVERHEAD ENTRANCE CANOPY
- 13. BLIDING BECURITY GATE ON TRACK
- 14. CONCRETE BOLLARDS (PER LADWP REDUREMENTS)
- 15. SHORT-TERM SIKE PARKING STALL TYP.
- 18. PROVIDE USPS APPROVED 4C MALBOXES (FOR X UNITS INCLUDING REQUIRED PARCEL STORAGE). CONTRACTOR TO VEREY LOCATION AND TYPE WITH POSTMASTER PRIOR TO PURCHASE AND INSTALLATION.
- 17. STUCCO FINISH (SEE ELEVATIONS FOR ADDIL FINISH INFORMATION)

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2002 KNOX AVE, 2ND PLOOR

LOS ANGELES, CA 90030

PROJECT NAME: 414 CROCKER STREET AFFORDABLE HOUSING

CLEST MANN: LITTLE TOKYO SERVICE CENTER


SIXTH FLOOR PLAN

PROJECT NUMBER Project Number DATE

Project Status Issue Deta Author Checker

A2.07

3/32" = 1'-0" Dt1927 - 414 Crocker Street(I) - Production(I) - Bohamatio Design(Rande(1)4 Crocker St - Enifferment Sat svt

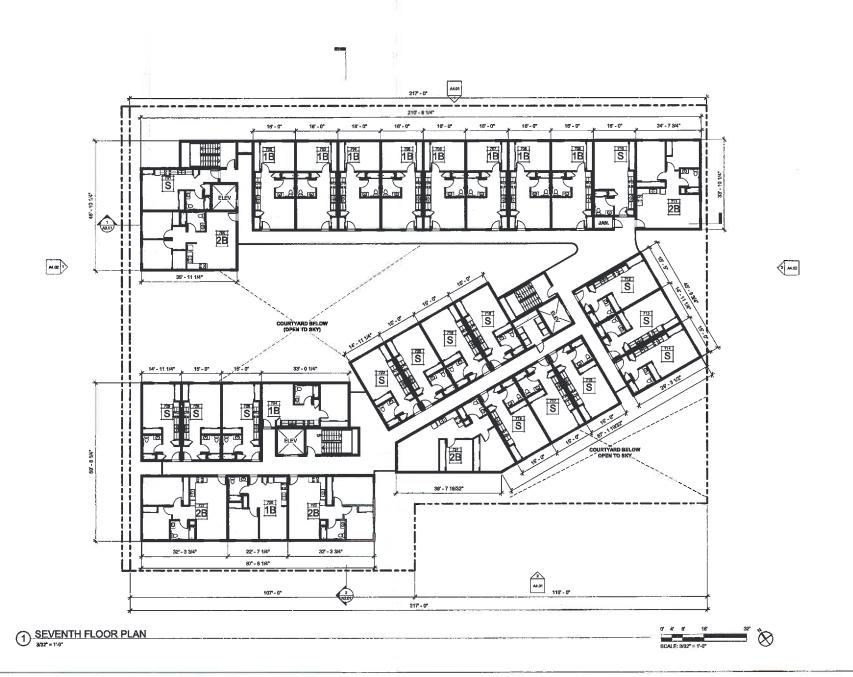

- 2 CONCRETE SLAH ON-GRADE
- 3. STRUCTURAL COLUMN (SEE STRUCTURAL URAWINGS)

- 7. STOREFRONT ASSEMBLY (ARCADIA OFFSE) DOUBLE GLAZING)

- 11. ON-GRADE PLANTERS (SEE LANDSCAPE

- 13. BLIDING SECURITY GATE ON TRACK
- 14, CONCRETE BOLLARDS (PER LADWP REQUIREMENTS)
- 16. PROVIDE USPS APPROVED 40 MALBOXES (FOR IS UNITS INCLIDING REQUIRED PARCEL STORAGE). CANTRACTOR TO VENEY LOCATION AND TYPE WITH POSTINASTES PRIOR TO PURCHASE AND NETALIATION.

LOS ANGELES, CA 90038 TEL: 323,255,4343 ARCHITECTS MALES EVARCHITECTS.COM

PROJECT NAME: 414 CROCKER STREET AFFORDABLE HOUSING PROJECT AUDIGESS: 414 S Crocker Street, Los Angeles, CA 90013

CLENT NAME. LITTLE TOKYO SERVICE CENTER

CLENT ADDRESS: 3431 Weekly Street, Suite Culver City, CA 90232

DRAWING TITLE: SEVENTH FLOOR PLAN

Project Number PROJECT NUMBER NO. DESCRIPTION DATE


NOT FOR CONSTRUCTION

Issue Data Author

A2.08

3/32" = 1'-0"

Q41927 - 414 Crocker Street/01 - Production/02_Sche Design/Revit/c14 Crocker St - Ent/fernent, Set.nt

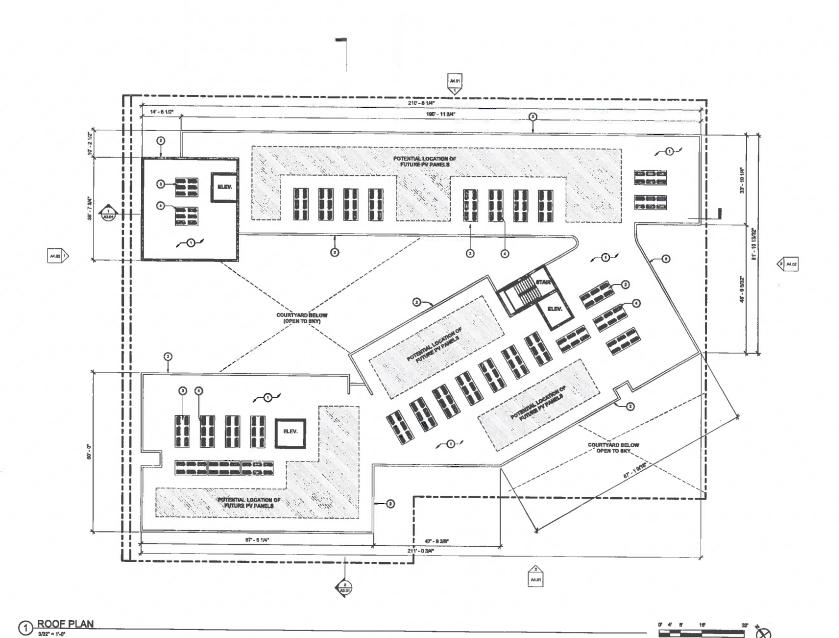

4. MECHANICAL CONDENSES LIMITS

6. SOLAR PANELS / SOLAR ZONE

LOS ANGELES, CA 90038 WWW.FSYVRCHITECTS.COM ARCHITECTS WALGESTARCHITECTS.COM

PROJECT NAME
414 CROCKER STREET
AFFORDABLE HOUSING

PROJECT ADDRESS: 414 S Crocker Street, 1.ce Angelos, CA 90013

CLERT MANE: LITTLE TOKYO SERVICE CENTER

DRAWING TITLE ROOF PLAN

PROJECT NUMBER Project Number NO. DESCRIPTION DATE

Project Status Issue Dete Author


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3/32" = 1'-0"

Okt 1927 - 414 Crocker Street O1 - Production IIIZ_Schematic Design Revisit 14 Crocker 31 - Entitiernent Belant

T.O. PARAPET 85'-0" Lau, والمسائم والمسائم والمسائم ROOF LEVEL 1 BEDROOM 2 BEDROOM 1 SEDROOM 2 BEDROOM 1 REDROOM 1 BEDROOM SEVENTH FLOOR 2 BEDROOM 1 BEDROOM * BEDROOM 1 REDROOM 1 REDROOM 1 REDROOM 1 REDROOM 1 SEDROOM SDCTH FLOOR 80" - 0" 2 BEDROOM 1 BEDROOM 1 BEDROOM 1 SEDROOM 1 BEDROOM 1 BEDROOM 1 BEDROOM 1 BEDROOM FIFTH FLOOR 6 1 SEDROOM 1 BEDROOM 1 BEDROOM 1 BEDROOM 1 BEDROOM 2 BEDROOM 2 BEDROOM FOURTH FLOOR 1 BEDROOM 1 BEDROOM 1 BEDROOM 1 BEDROOM 2 REDROOM 2 BEDROOM THIRD FLOOR 99'- 0" 2 BEDROOM 1 BEDROOM 1 BEDROOM 1 REDROOM 1 BEDROOM 1 BEDROOM 1 BEDROOM 2 BEDROOM SECOND FLOOR 16'-0" COVERED ENTRY GROUNISTREET O'-0'-0' _01_SUB-FLOOR

LONGITUDINAL SECTION

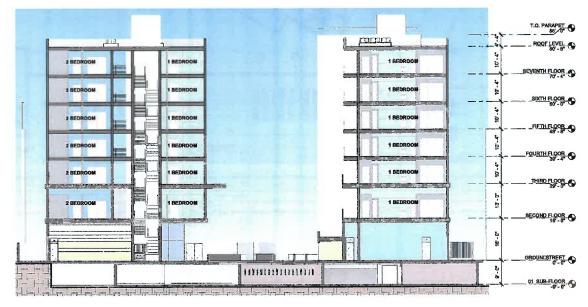

2 TRANSVERSE SECTION

ARCHITECTS MALESTSYARCHITECTS.COM

LOS ANGELES, CA 90039 WWW.PSYARCHITECTS.COM

PROJECT NAME: 414 CROCKER STREET AFFORDABLE HOUSING PROJECT ADDRESS: 414 S Crocker Street,

CLIENT NAME: LITTLE TOKYO SERVICE CENTER CLERIT ADDRESS: 3431 Wesley Street, Suits F Cuiver City, CA 90232

DRAWING TITLE: BUILDING SECTION

PROJECT NUMBER

Project Number NO. DESCRIPTION DATE


NOT FOR CONSTRUCTION

Project Status Date Issue Date Drawn by Checked by Author Checker

A3.01 3/32" = 1'-0"

0:(1827 - 414 Crocker Street/01 - Production/02 IS Design/RevIS414 Crocker St - Entitlement Seturk



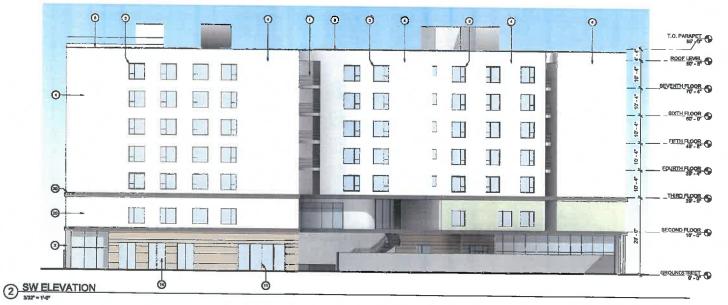

1. 42 TALL METAL PICKET GUARDRAIL

2. STRUCTURAL COLUMN

3. VMYLWINDOW W/ ALLMINEM PINEM

4. STUCCO FINISH (LA HABRA - COLOR VARXES)

E. STUCCO CONTROL JOINT

B. STOREFRONT ASSEMBLY (ARCADIA - DEFSET DOUBLE GLAZING).

STOREFRONT DOOR ASSEMBLY (ARCADIA - OFFSET DOUBLE GLAZING)

IL SHEET METAL COPING (COLOR MATCHED TO STUCCO)

II. PERIMETER FENCE

10. STRUCTURAL BEAM 11. CURTAIN WALL

12 METAL AWNING

13, 18" CONCRETE PLOOR SLAB

14. WOOD CLADONG

15. UTILITY POLE



2902 KNOX AVE, 2ND FLOOR LOS ANGELES, CA 90038 TEL: 323.255.4343

PROJECT NAME: 414 CROCKER STREET AFFORDABLE HOUSING PROJECT ADDRESS: 414 S Crooker Street, Los Angeles, CA 90013

CLENT NAME: LITTLE TOKYO SERVICE CENTER

CLERIT ADDRESS: S431 Washing Street, Bulto F Cultur City, CA 90222

DRAWING TITLE: BUILDING ELEVATION


PROJECT NUMBER Project Number NO. DESCRIPTION DATE

NOT FOR CONSTRUCTION

Project Status leave Date Drawn by Author Checker

A4.01

3/32" = 1'-0" Ott1927 - 414 Crocker Street/01 - Production/02_Schemetic DesignRevIN414 Crocker St - Entherment Set.nc

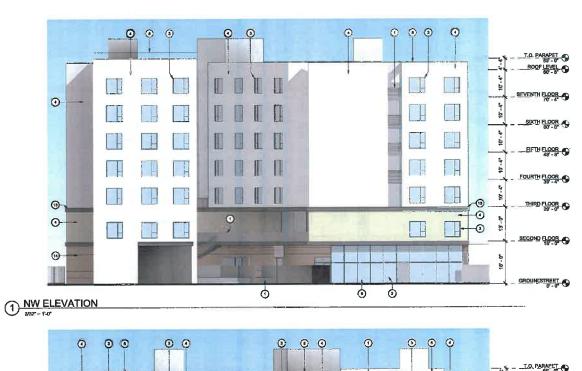

T.O. PARAPET (9 ROOF LEVEL SEVENTH FLOOR SIXTH FLOOR O FIFTH FLOOR FOURTH FLOOR 9 13)-13 THIRD FLOOR (0 -0 **10**-SECOND FLOOR 0 GROUNDSTREET & 0 0 (B) (D) (2)

1. 42" TALL METAL PICKET GUARDRAI

2. STRUCTURAL COLUMN

3. VINYL WINDOW W/ ALLMINUM FINISH 4. STUCCO FINISH (LA HARRA - COLOR VARIES)

6. STUCCO CONTROL JOINT

E. STORE-FRONT ASSEMBLY (ARCADIA - OFFSET DOUBLE GLAZING).

STORETRONT DOOR ASSEMBLY (ARCADIA: OFFSET DOUBLE GLAZING)

5. SHEET METAL COPING (COLOR MAYCHED TO STUCCO)

9. PERMETER FENCE

10. STRUCTURAL BEAM 11. CURTAIN WALL

12 METAL AWNING

13. 1 F CONCRETE FLOOR SLAR 14. WOOD CLADDING

15. UTLITY POLE

ARCHITECTS MALGREYARCHITECTS.COM

2802 KINOX AVE, 2ND FLOOR LOS ANGELES, CA 90009 TEL: 323.255.4343 WWW.FSYARCHITECTS.COM

PROJECT NAME: 414 CROCKER STREET AFFORDABLE HOUSING PHOJECT ADDRESS: 414 S Crocker Street, Los Angeles, CA 90013

CLENT NAME: LITTLE TOKYO SERVICE CENTER

CLIENT ADDRESS: 3431 Wesley Street, Suite F Curver City, CA 90232 DRAWING TITLE:

BUILDING ELEVATION

PROJECT NUMBER Project Number NO. DESCRIPTION DATE

NOT FOR CONSTRUCTION

Issue Date

Author Checker

Project Status

A4.02

3/32" = 1'-0" 0/1927 - 414 Orocian Street/01 - Production/02_Sche Design@RevIS414 Orocian Rt - Entitlement Seture

2 SE ELEVATION
3/32"= 1'-0"



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	and the state of t	THE STATE OF THE S	
Sales Sales			

TREE LEGENO

SYM	BOTANICAL NAME	COMMON NAME	SIZE	QTY.	REMARKS	WUCOLS
0	a Cupressus s. 'Glesce'	Italian Cypress	15-cm	11		lew 0.3
	n Draceens drace	Drugun Tree	15-gal			low 0,3
₩	+ Goljone perviflene	Australian Willow	24"bex	4		low 0.3
Ŏ	= Laurus nobilis	Sweet Boy	15-gal	7		low 0.3
\odot	 Lyenethenness floribundes 	Catalina Irenwood	15-gal	15		lew 0.3
Ø.	* Schinus mella	Cal Papper True	24°bex	2		low 0.3
0	Street tree	Per City req.	15-gal	7		low 0.3

SHRUBS AND GROUND COVER LEGEND

SYM.	BOTANICAL NAME	COMMON NAME	SIZE	QTY.	REMARKS	WUCOL5
000	Agave attementa 'Voriegata'		5-gal	15		low 0.3
(e)	+ Aspidistra eletion	Cost Iron Plant	5-gal	57		lew 0,3
	« Carex divules	Berhaley Sedge	5-gal	69		lew 0.3
10	* Chandrapetakan alaphantinum	Large Cape Rush	5-gal	23	1	Jow 0.3
⊙	- Cordyline a, 'Red Ster'		5-gal	7	1	low 0.3
0000	a Dianella r. Little Rev	Flex Lifly	5-gal	24		low 0.3
1 ⊙	Dietes bicelor	Fortnight Lily	5-gal	19	1	low 0,3
10	« Lomandra I, "Matinum Beauty"	Dwarf Mat Rush	5-gal	73	1	low 0,3
10	· Myrtut communis 'Compacta'	Myrtle	5-gal	6		law 0.3
O	Xylosma congestum compactu	· ·	5-gel	6		low 0,3

« Points claimed for low water

All trees to be planted with commercial root barriers. 3" deep streeded Coder bank to spread between plants.

NOTE:

NAI groundcover eract where plants are 3'ec or gracter to have 2 layers of gestectific febric in 2 different directions geotectific febric installed 3" below finished grade w/ 3" stredded bank above to eliminate weed growth.

Waterproofing and drains in planters by others.

PLANTING NOTICE

- SEAMEN BY SHARM SHIP COUNT ALL PLANT IN ATTENNAL METONS SHIP CONDITIONS ON HERE. COUNT ALL PLANT IN TERMAL METONS SECONS.
- 2. CONTRACTOR TO REPERT ALL PROTECTIONS ON MYS AND LOCATE ALL EXECUTED SYLVING REPORT CONSTITUCTION BROWN.
- CONTRACTOR TO REPAIR AT HE OWN EXPENSE ALL PROPERTY DAMME WHICH OCCURS BURNIN PRODUCT SEEPALLYTON.
- 4. NOTE ADDITIONAL REMARKS ON SPECIFIC FLAKTS IN FLANT LIST.
- R. ALL EXETTING PLANT INTERNAL TO BE PRINCIPED EXCEPT WHERE NOTED ON PLAN.
- CONTRACTOR TO GENERATE ALL PLANT MATERIAL FOR SO BAYS PROX THE DATE OF ACCOPTANCE BY SHIRIN. PALK TO BE QUANALIZED FOR THE PERIOD OF 1 YEAR.
- 7. PRIGH GRADE TO BE 2" MELOW ALL WALKS, CURES, AND PAYES.
- ALL FLANTED MIGHE SHALL RECEIVE THE FOLLOWING MICHORISHTE FOR 1,000 BQ, FT, OF BURKACE MIGH DICKY-TILL AMBROMENTS TO A DISTRICT OF F

*100 LBIO, OPC-POINTER *3 CU YOS NOT ROGERMEND, INTERPRETATION PRE BANK *NOO B LBIO OF GREE-POINTER CONTROLLED HIS LEAVE 124-R PER CU YO CF MIS,

R. PLANT HOLE TO BE TWICE AS WIDE AND DEEP AS THE PLANT PLOYS SMLL. SHC-SPLL, AND COMMINGS TO SE S. SOIL OF SITE AND 20 S. FIR BANK, AS SERVICES SE SE, TROVINGS SHC-PUNKS PLANT TAILLESS AT THE POLLOWING SHUTS:

PLACE PROGRAMMING THRUST SET WITH THE BOX TOW AND THE TOP OF THE ROOT BALL BUT ROD WINESS THAN 15 OF THE HIST UP TO THE TOP OF THE ROOT BALL PARCE THRUSTS BURLLY AROUND THE PRIMISETING OF THE ROOT BALL PRYNORIBITIES 2" FRIGHT THE ROOT TOT, PALL THESE ARE NOT TO RECEIVE THALEST

- 98. ALL PROPOSEDES BRILLING DESCRICTOR CONTROLL TO MALE TO BE TREATED WITH A PERSONAL TRANSPORT WITHOUT STREAM CONTROLLING SETTIME (PROSE TORS). A PETAT PER MANAGEMENT STREAM CONTROLLING SETTIME (PROSE TORS) A PETAT PETAT
- 11. CONTRACTOR TO INSTITUL ARE BRINTING LANDONS PLANTING IN ACCOMMUNICATION TO INSTITUL ARE DEVENUES AND ACCOMMUNICATION SHELLIS MOVED OTHERWISE IN THEIR HOTTER OR ON THE PLANTING IN THEIR HOTTER OR ON THE PLANTING IN TH
- 12. BOIL BARFLER TAKEN FINCEN WHICUS LOCATIONS IN THE PLANTING AVISING WILLIES SHEET TO A SOIL LISE FOR PROFESSIONAL AVALYSIS AND RECONSISTENT FOR SOIL PROFESSIONAL AVALYSIS AND RECONSISTENT TO FULL DAY SOIL TRITTED RECONSISTENTATIONS.
- TH. USE OF CLASS I OR CLASS II COMPOST-HODUCES USING CITY CRIMANC INVESTMENT (PERSONS MAIN INJUSTRY OF LINCOSCHEED AND A



ASLA

Yael Lir Landscope Architects 1010 Sycomore Ave. Suite 313 South Pasadena, CA 91030 Tel 323.258.5222 Fax 323.258.5333 yael@yaellir.com

175 UNIT APARTMENT
414 CROCKER ST.
LOS ANGELES, CA 90013

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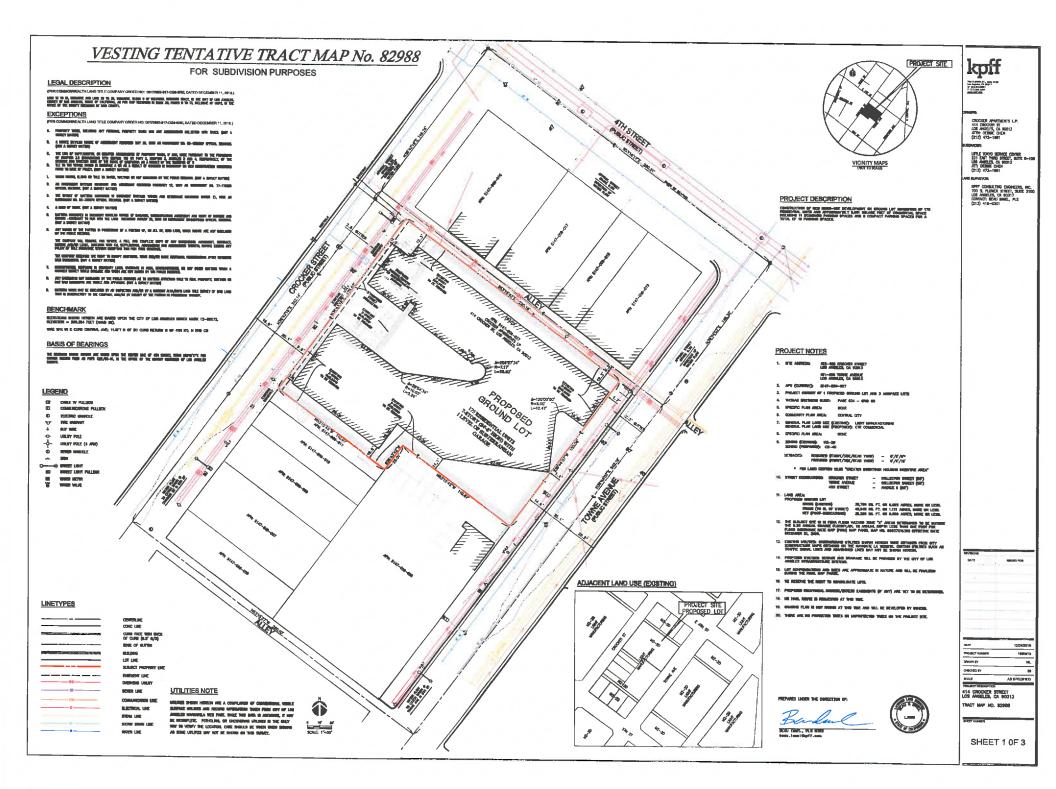
PLANTING PLAN





DATE:	DEC. 16, 2019
SCALE:	1/18"=1'-0"
JOB NUMBER:	215019
DRAWN BY:	

1.-1

KER ST	Committee State Committee Stat
CROCKER	
⊙ Several from per (g)	Samura Variable (s) Table 1 and 1 a
	© tentiment for bendar Designation Desi



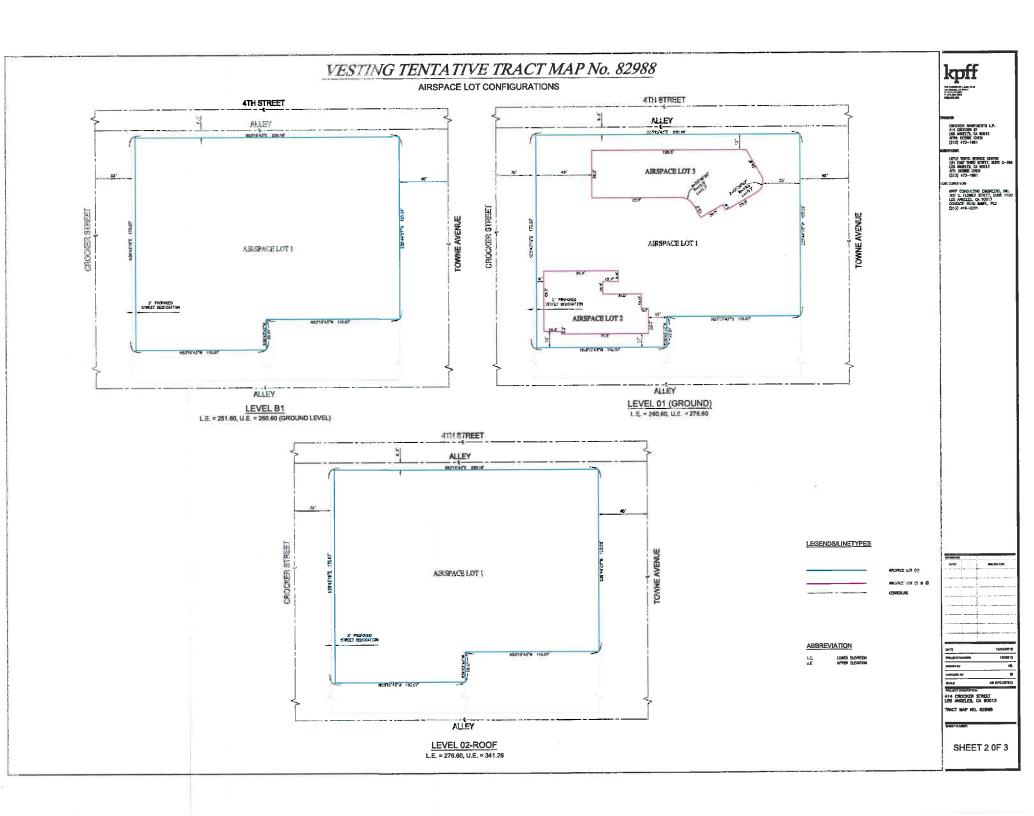

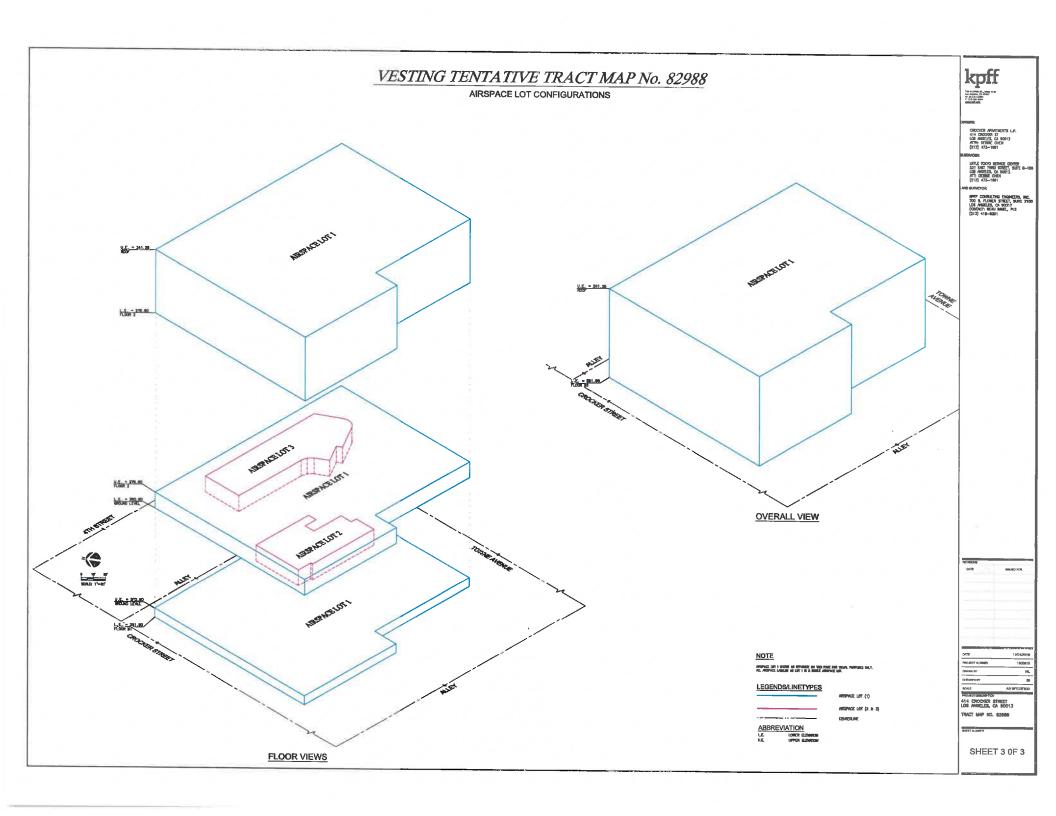

Attachment 2

DEPARTMENT OF CITY PLANNING

COMMISSION OFFICE (213) 978-1300

CITY PLANNING COMMISSION

SAMANTHA MILLMAN PRESIDENT

VAHID KHORSAND VICE-PRESIDENT

DAVID H. J. AMBROZ CAROLINE CHOE HELEN LEUNG KAREN MACK MARC MITCHELL VERONICA PADILLA-CAMPOS DANA M. PERLMAN

CITY OF LOS ANGELES

CALIFORNIA



ERIC GARCETTI MAYOR EXECUTIVE OFFICES

200 N. SPRING STREET, ROOM 525 LOS ANGELES, CA 90012-4801 (213) 978-1271

VINCENT P. BERTONI, AICP DIRECTOR

KEVIN J. KELLER, AICP EXECUTIVE OFFICER

SHANA M.M. BONSTIN DEPUTY DIRECTOR

TRICIA KEANE DEPUTY DIRECTOR

ARTHI L. VARMA, AICP DEPUTY DIRECTOR

LISA M. WEBBER, AICP

PRIORITY HOUSING PROJECT

Filing Notification and Distribution

Tract Map No. VII-82988-HCA & CPC-2020-87-	Distribution Date: January 15, 2020			
GPAJ-ZCJ-SPR-HCA Tract Map Date: January 07, 2020 Property Address: 412-426 Crocker St &411-425 Twone Ave.	Case Filing Date: January 07, 2020			
Community Plan: Central City				
☑ COUNCIL DISTRICT NO. 14	Hillside ☐ Yes ⊠ No			
Neighborhood Council District: ☑ Downtown Los Angeles	⊠ Bureau of Sanitation			
⊠ Bureau of Engineering	Dureau of Sanitation			
□ Dept. of Building and Safety - Grading	St. Services / Investigation & Enforcement-(hau routes - email ONLY: bss.haulroute@lacity.org			
□ Dept. of Building and Safety – Zoning	□ Urban Forestry / Land Development Section			
□ Dept. of Transportation	⊠ Housing Department (No P.S.)			
□ DWP Real Estate	☑ Board of Education/Environmental Health &			
□ DWP Water Distribution Engineering	Safety (No P.S.)			
□ Dept. of Fire, Engineering and Hydrant Unit	☑ Board of Education/Transportation (No P.S.)			
	☑ County Health Department (No P.S.)			
Bureau of Street Lighting	⊠ GIS (Final Map & LOD)			
☐ Animal Regulation (Hillside-ONLY)				
Department of Recreation and Parks				

DATE DUE: UPON RECEIPT

Please send your reports to the following e-mail address: hagu.soloman-cary@lacity.org and maria.reyes@lacity. Thank you.

Pursuant to Sections 17.50 through 17.60 of the Los Angeles Municipal Code, the attached tentative tract map is submitted for your consideration. The Advisory Agency will await your report and recommendation regarding the above matter for 39 days. If we have not received a written report from you after 40 days from the date of filing, we will assume that you have no report to make.


VINCENT P. BERTONI, AICP Advisory Agency

Kevin Golden Deputy Advisory Agency 200 N. Spring Street, Room 621







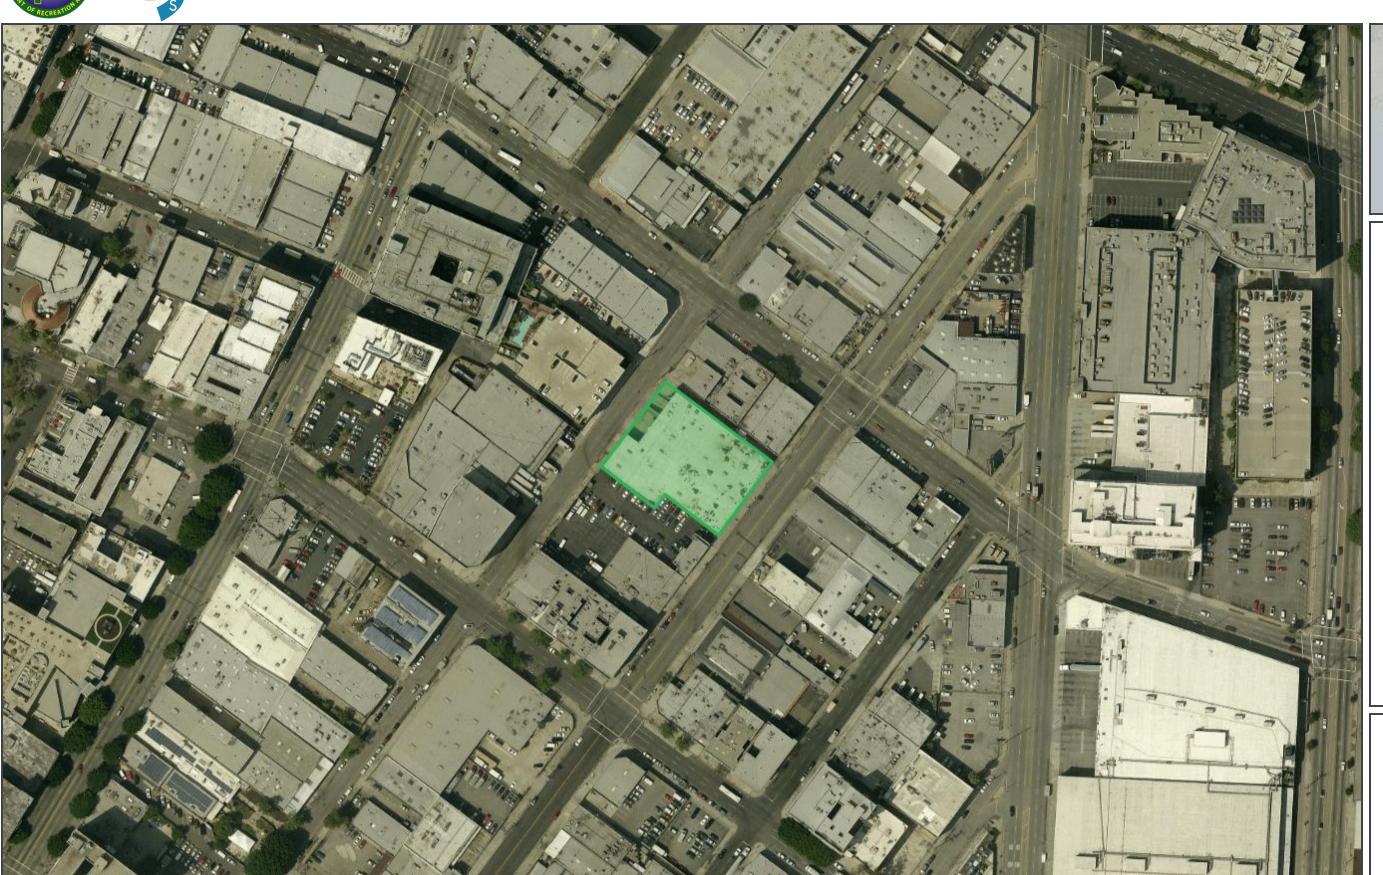



LEGEND

City Limits


City Limit

NOTES

SCALE 1: 2,257

Attachment 4

City of Los Angeles Department of City Planning 04/06/2020

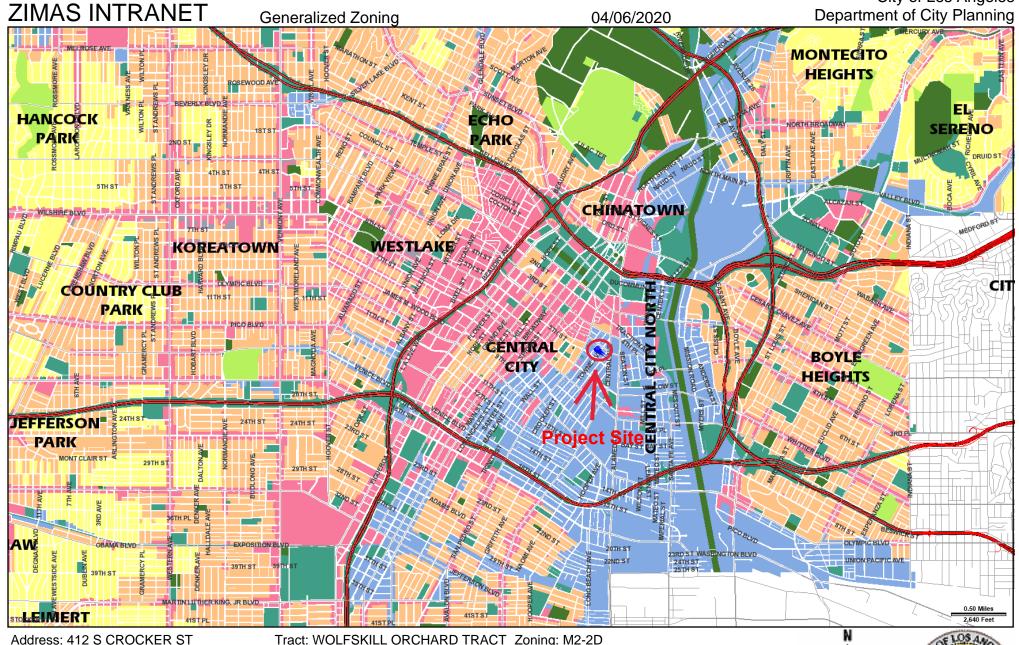

APN: 5147009027 PIN #: 127-5A213 178 Tract: WOLFSKILL ORCHARD TRACT Zoning: M2-2D

Block: 9 General Plan: Light Manufacturing


Lot: 21 Arb: None



Project Location and Surrounding Parks




Printed: 02/25/2020

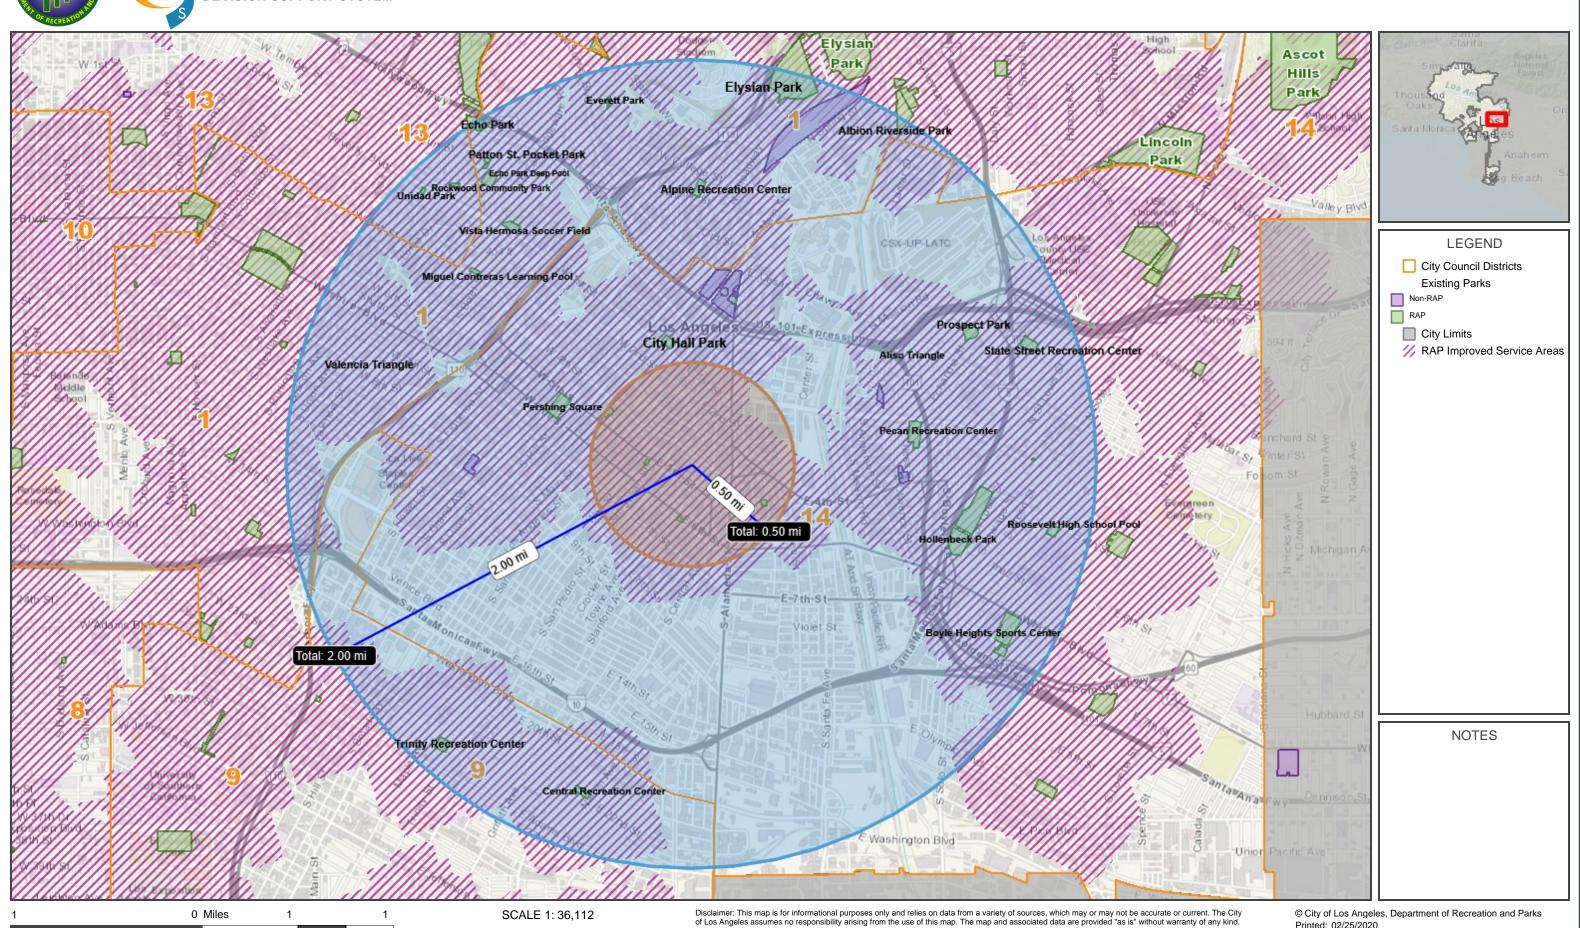





Park Analysis Report

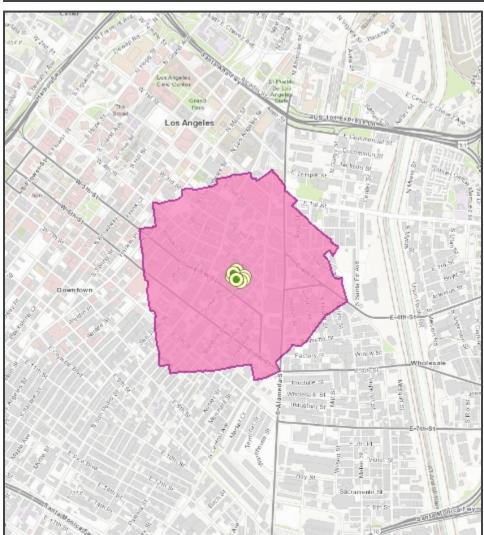

Scenario Information

Scenario Name:

VTT-82988

Description:

mixed use 100% affordable housing w/ 175 units, 8,691 sq ft of commercial use, 19 parking stalls, and 125 bicycle stalls

Scenario Type:

New Park

Park Class:

Improved

Baseline Dataset*:

All Parks (RAP and Non-RAP)

*The baseline dataset is the existing parks dataset whose service areas are used to calculate the currently non-served metrics given below in blue. These residents and households, which would be served by the proposed park, are not currently served by any existing park in the baseline dataset.

Population and Age Breakdown

Household and Income Breakdown

Total Residents Currently Non-Served Served: Total Households Currently Non-Served Households Served: Served: Households Served:

Residents Served: 12,829 0 Households Served: 5,183 0

Resider	nts Served by Age		Households Served by Annual Income			
Under Age 5:	174	0	Under \$25,000:	3,537	0	
Age 5 to 9:	160	0	\$25,000 to \$34,999:	288	0	
Age 10 to 14:	188	0	\$35,000 to \$49,999:	302	0	
Age 15 to 17:	119	0	\$50,000 to \$74,999:	428	0	
Age 18 to 64:	10,456	0	\$75,000 and Over:	628	0	
Age 65 and Over:	1,732	0		Source	e: Census/ACS 2010	

City of Los Angeles Department of Recreation and Parks Date Generated: 02/24/2020 Disclaimer: This report is for informational purposes only and relies on data from a variety of sources, which may or may not be accurate or current. The City of Los Angeles assumes no responsibility arising from the use of this report. The map and associated data are provided "as is" without warranty of any kind.